




FRONT ELEVATION.

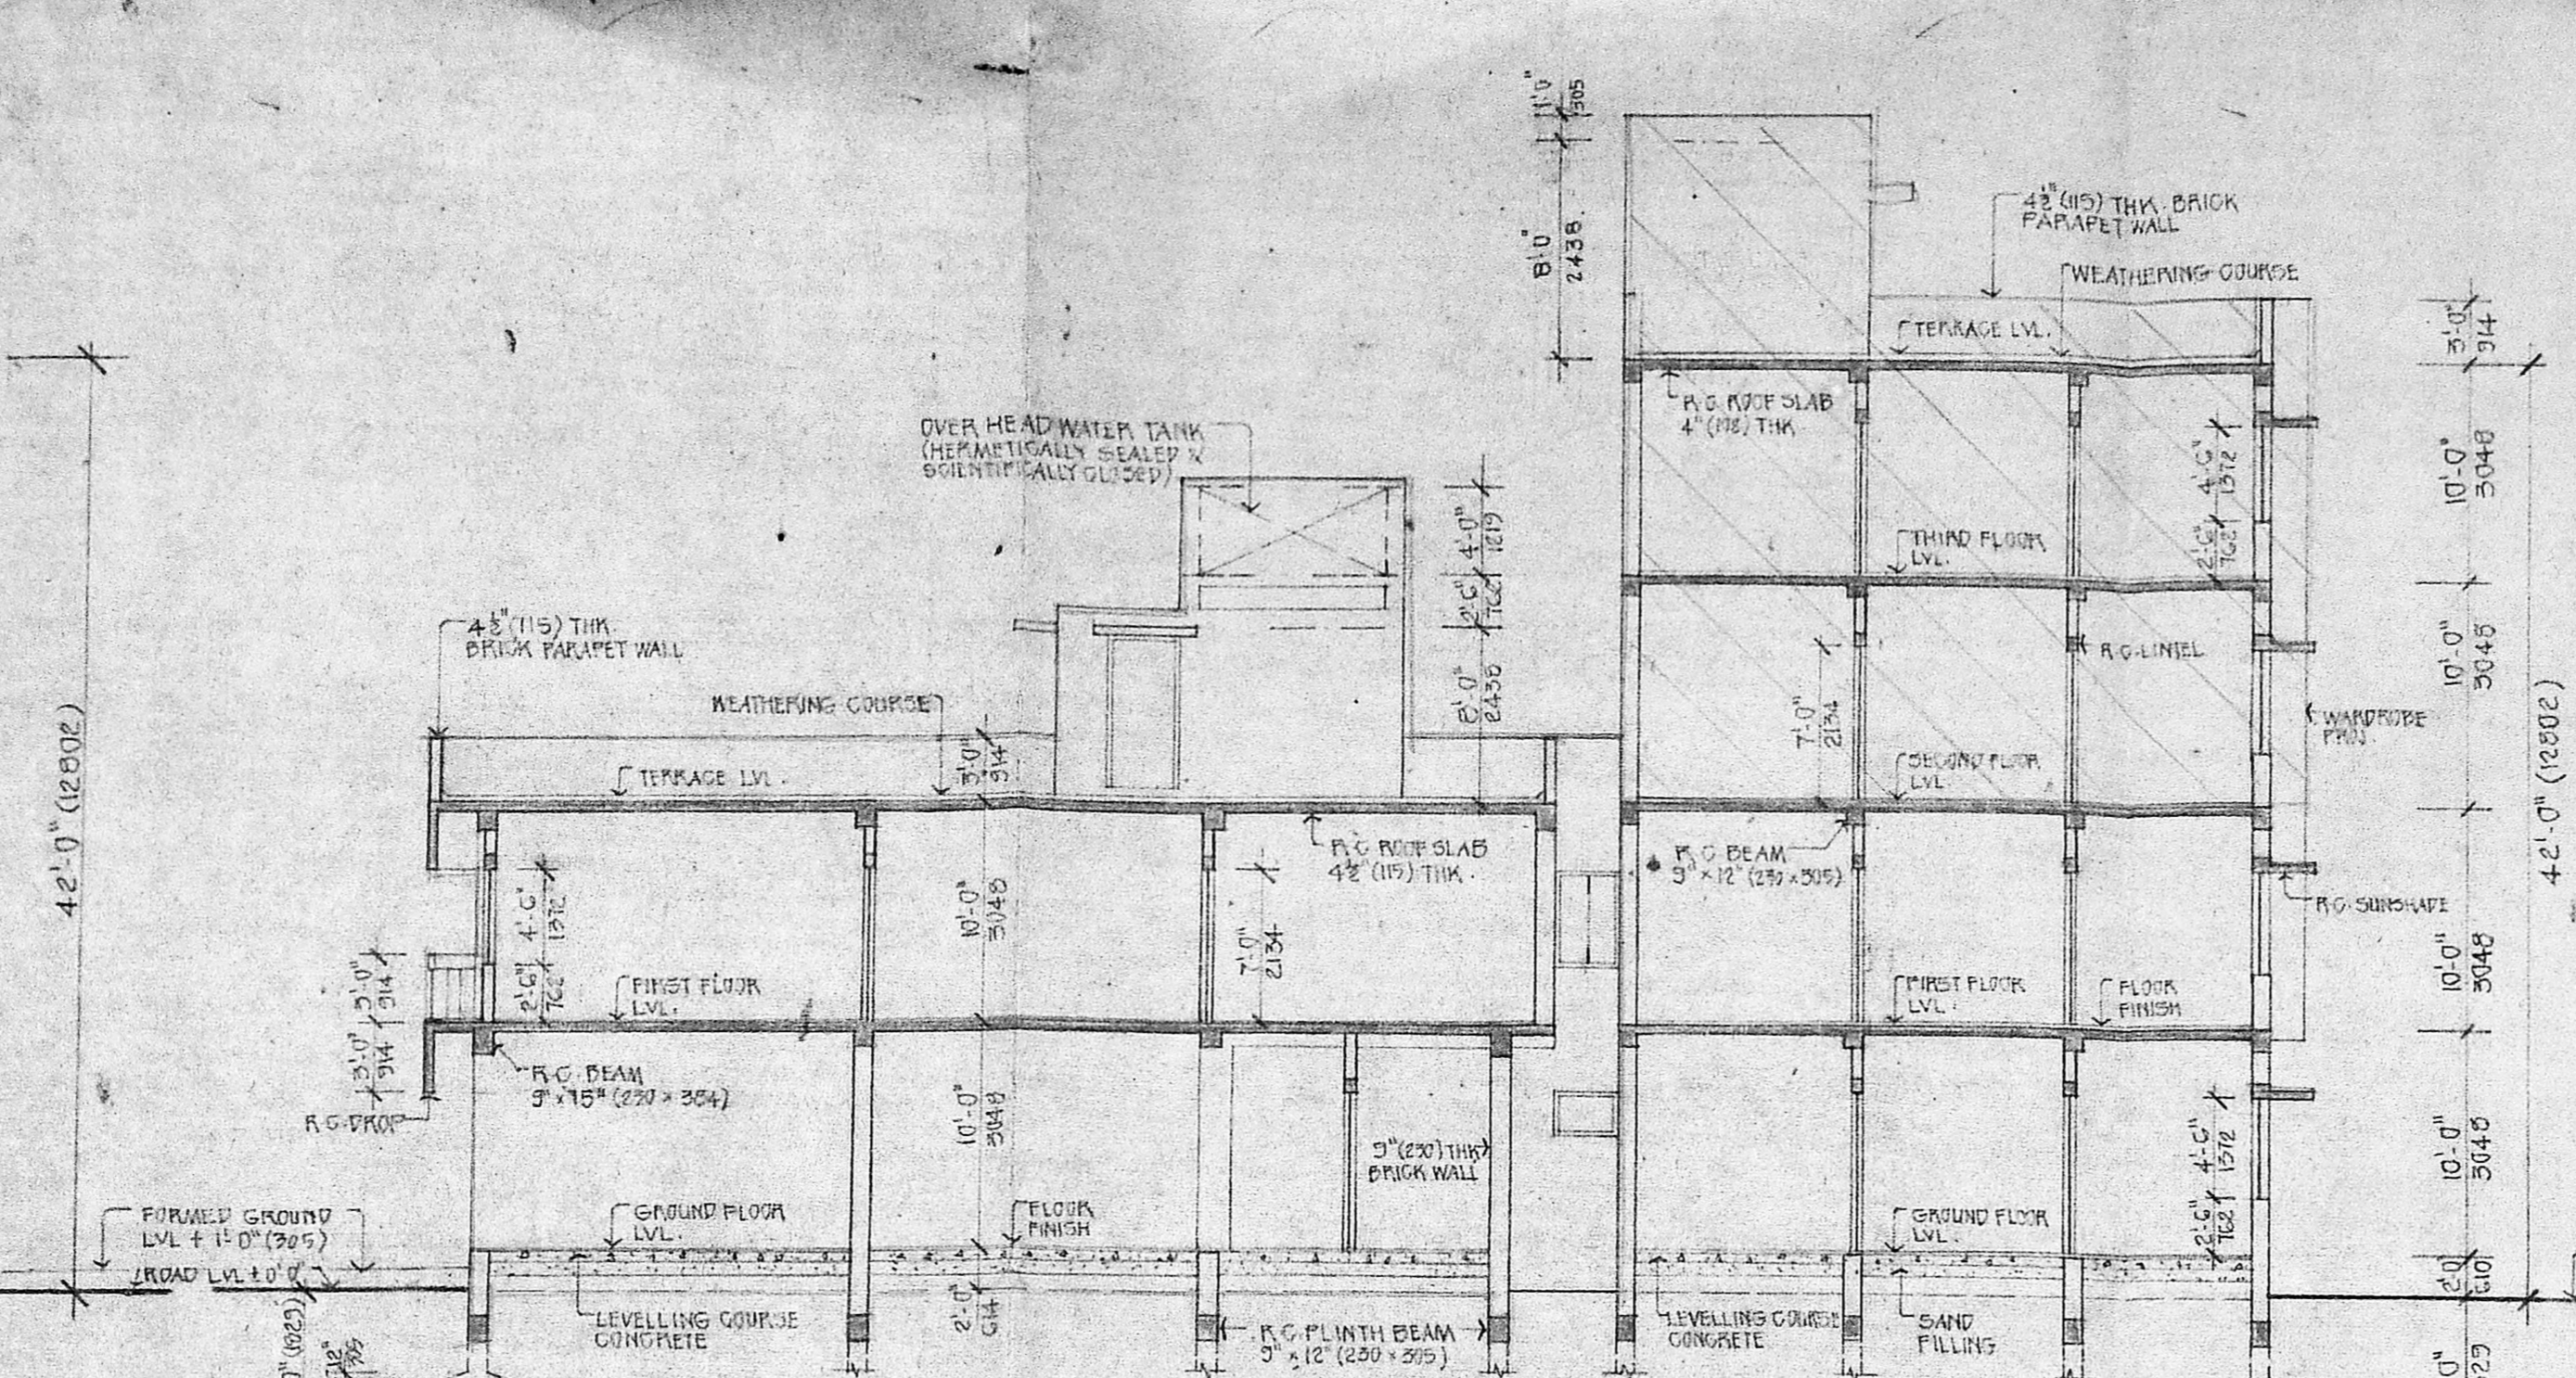

SECTION A-B.

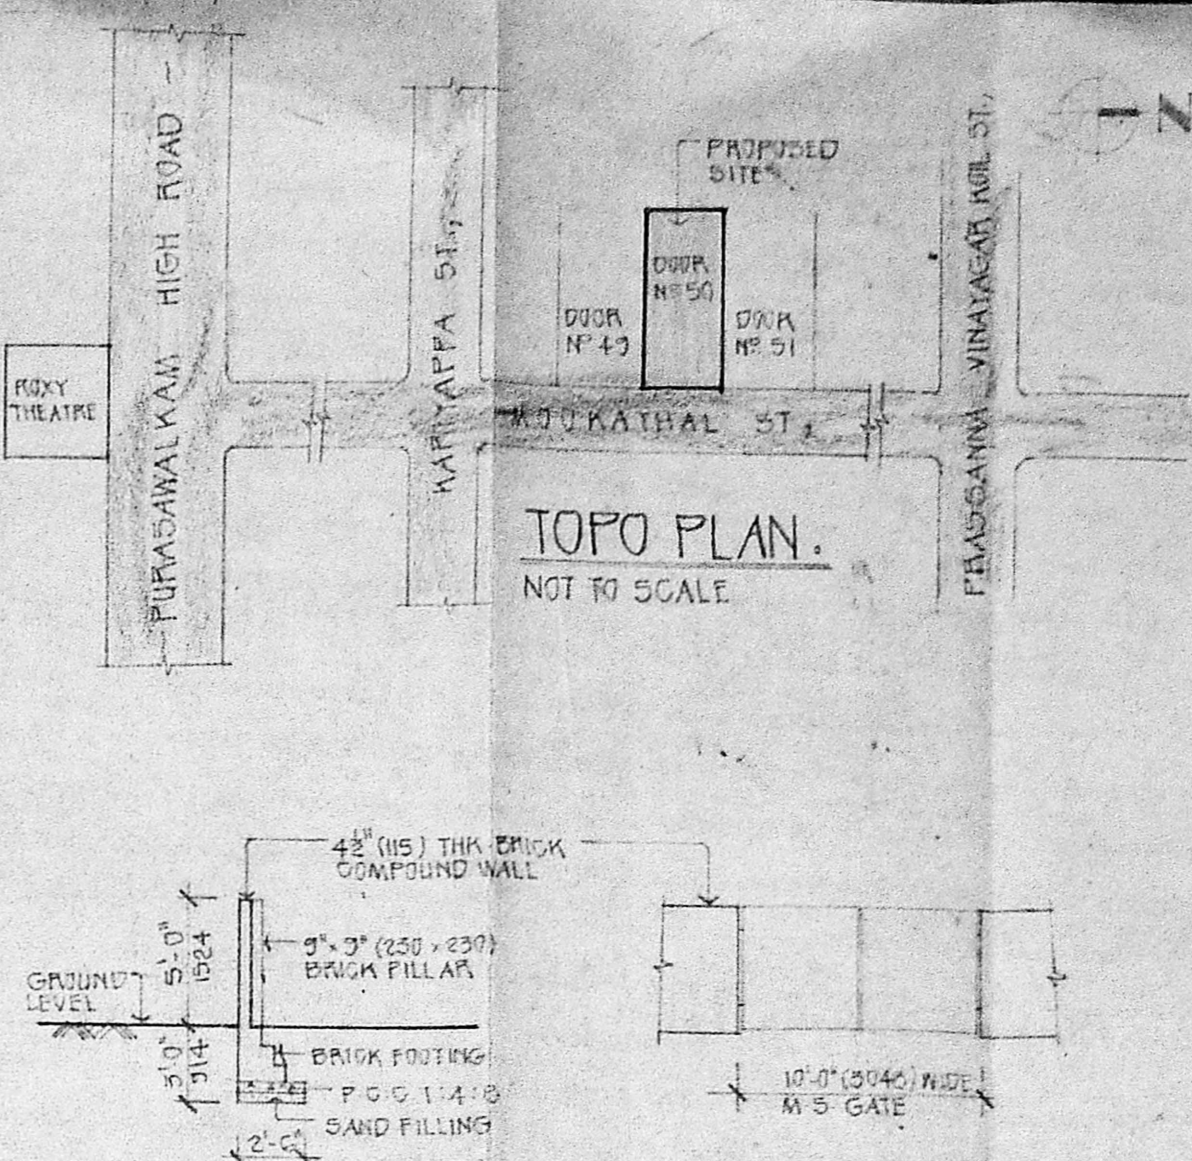

TOPO PLAN.
NOT TO SCALE.

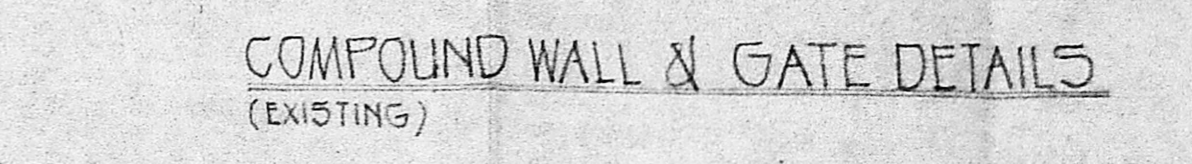

COMPOUND WALL & GATE DETAILS
(EXISTING)


COLOUR INDEX

EXISTING	
PROPOSED	
ROAD	
BOUNDARY LINE	
DRAINAGE LINE	
DRINKING WATER LINE	
EXISTING TO BE SANCTIONED	


SCHEDULE OF JOINERY

D1	5'-0" x 7'-0"	1634 x 2134	TEAK WOOD GLAZED WINDOW
D2	3'-0" x 7'-0"	914 x 2134	TEAK WOOD GLAZED WINDOW
D3	3'-0" x 7'-0"	914 x 2134	TEAK WOOD GLAZED WINDOW
D4	2'-0" x 7'-0"	635 x 2134	TEAK WOOD GLAZED WINDOW
D5	2'-0" x 7'-0"	635 x 2134	TEAK WOOD GLAZED WINDOW
D6	4'-0" x 7'-0"	1270 x 2134	TEAK WOOD GLAZED WINDOW
W1	6'-0" x 4'-0"	1827 x 1270	TEAK WOOD GLAZED WINDOW
W2	5'-0" x 4'-0"	1548 x 1270	TEAK WOOD GLAZED WINDOW
W3	4'-0" x 4'-0"	1270 x 1270	TEAK WOOD GLAZED WINDOW
W4	4'-0" x 4'-0"	1270 x 1270	TEAK WOOD GLAZED WINDOW
W5	5'-0" x 3'-0"	1548 x 914	TEAK WOOD GLAZED WINDOW
W6	5'-0" x 3'-0"	1548 x 914	TEAK WOOD GLAZED WINDOW
J1	5'-0" x 0'-0"	1548 x 2430	TEAK WOOD GLAZED WINDOW
R.S.1	1'-0" x 8'-0"	305 x 2430	ROLLING SHUTTER
R.S.2	1'-0" x 8'-0"	305 x 2430	ROLLING SHUTTER
V1	4'-0" x 2'-0"	1270 x 635	TEAK WOOD GLAZED WINDOW
V2	5'-0" x 2'-0"	1548 x 635	TEAK WOOD GLAZED WINDOW
W.C.	2'-3" x 4'-0"	635 x 1270	TEAK WOOD GLAZED WINDOW


- SPECIFICATIONS.
- FOUNDATION - R.C. ISOLATED COLUMN FOOTING SUITABLY REINFORCED WITH C.M. 1:5, P.C. 1:4:8 & SAND FILLING.
 - BRICK WORK - BRICK WITH IN C.M. 1:6 IN BASEMENT & 1:5 IN SUPER STRUCTURE.
 - ROOFING - R.C. SLAB 1:2:4 WITH 0.5% OF REINFORCEMENT.
 - WATER PROOFING - SLOPE CONCRETE WITH BRICK JELLY IN LINE AND ONE COURSE OF FLAT TILES SET IN C.M. 1:3 MIXED WITH GRADE OIL & POINTED WITH C.M. 1:3 & RUBBED SMOOTH.
 - PLASTERING - WALLS & CEILINGS IN 12MM THK C.M. 1:4.
 - FLOORING - GROUND FLOOR - MOSAIC FLOORING OVER A LAYER OF P.C. 1:4:8 & SAND FILLING.
 - UPPER FLOORS - MOSAIC FLOORING OVER R.C. SLAB.
 - FINISHES - INTERIOR PAINTED WITH DRY DISTEMPER. EXTERIOR PAINTED WITH CEMENT PAINT.
 - DOORS & WINDOWS PAINTED WITH SYNTHETIC ENAMEL PAINT OVER A PRIMING COAT OF WOODEN PRIMER.

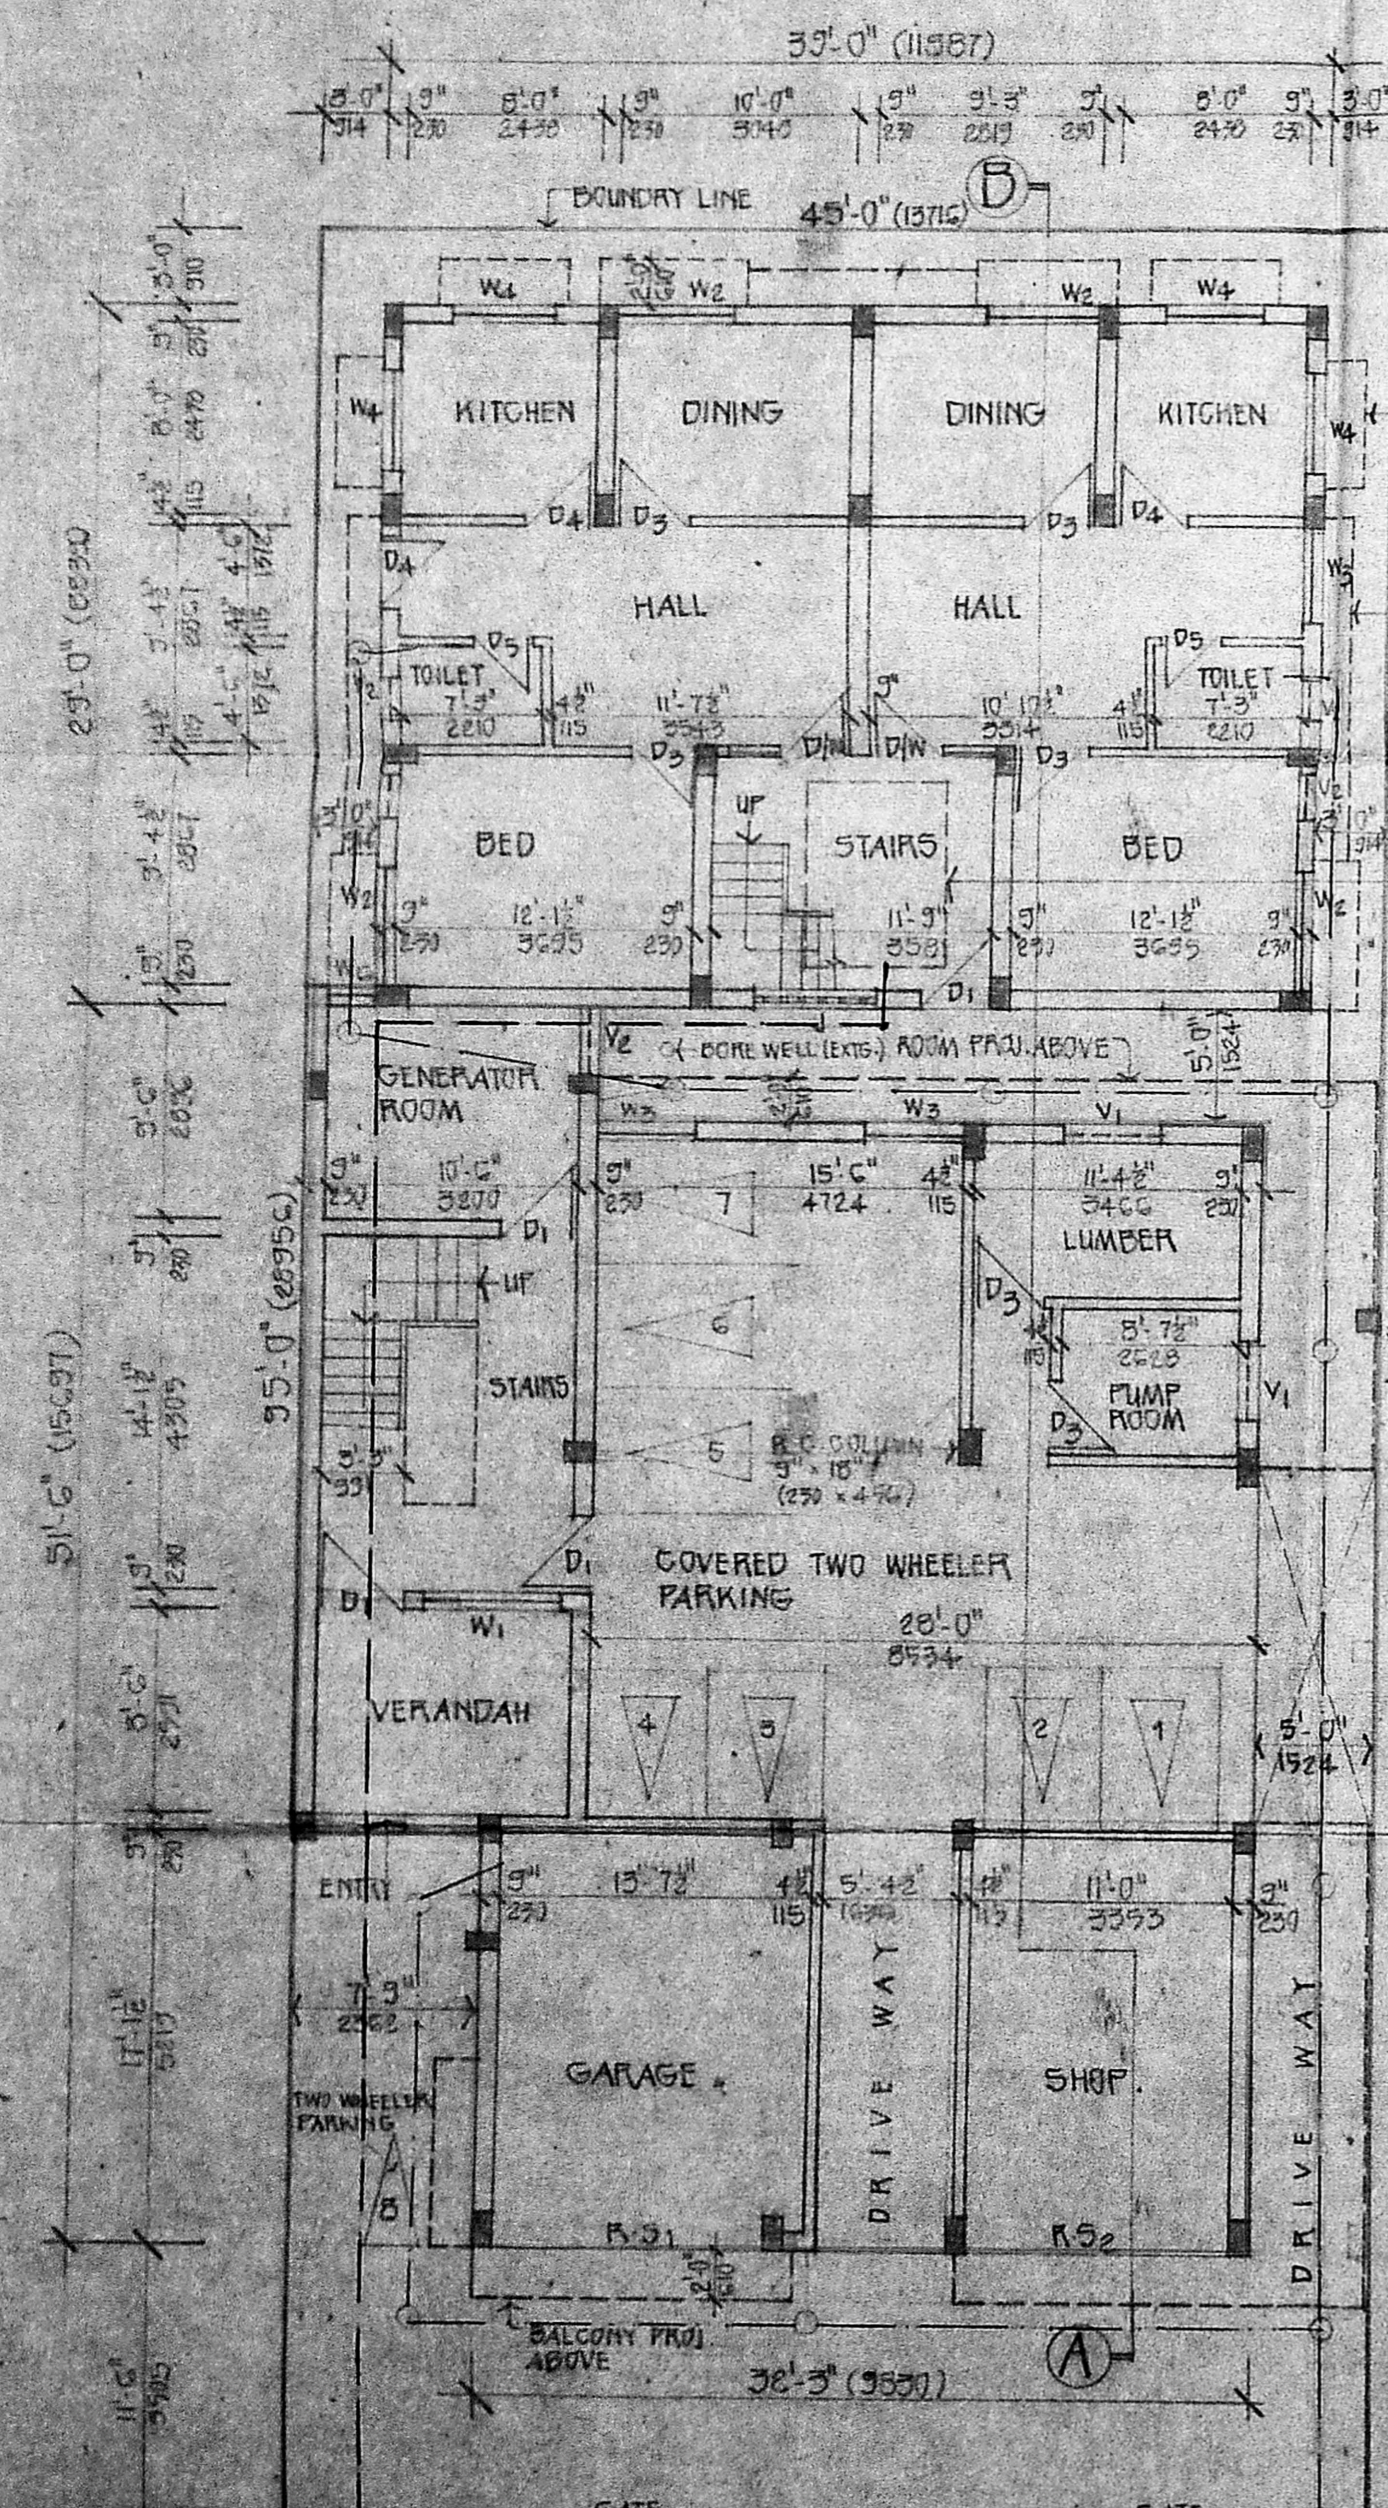


GROUND FLOOR PLAN CUM SITE PLAN.

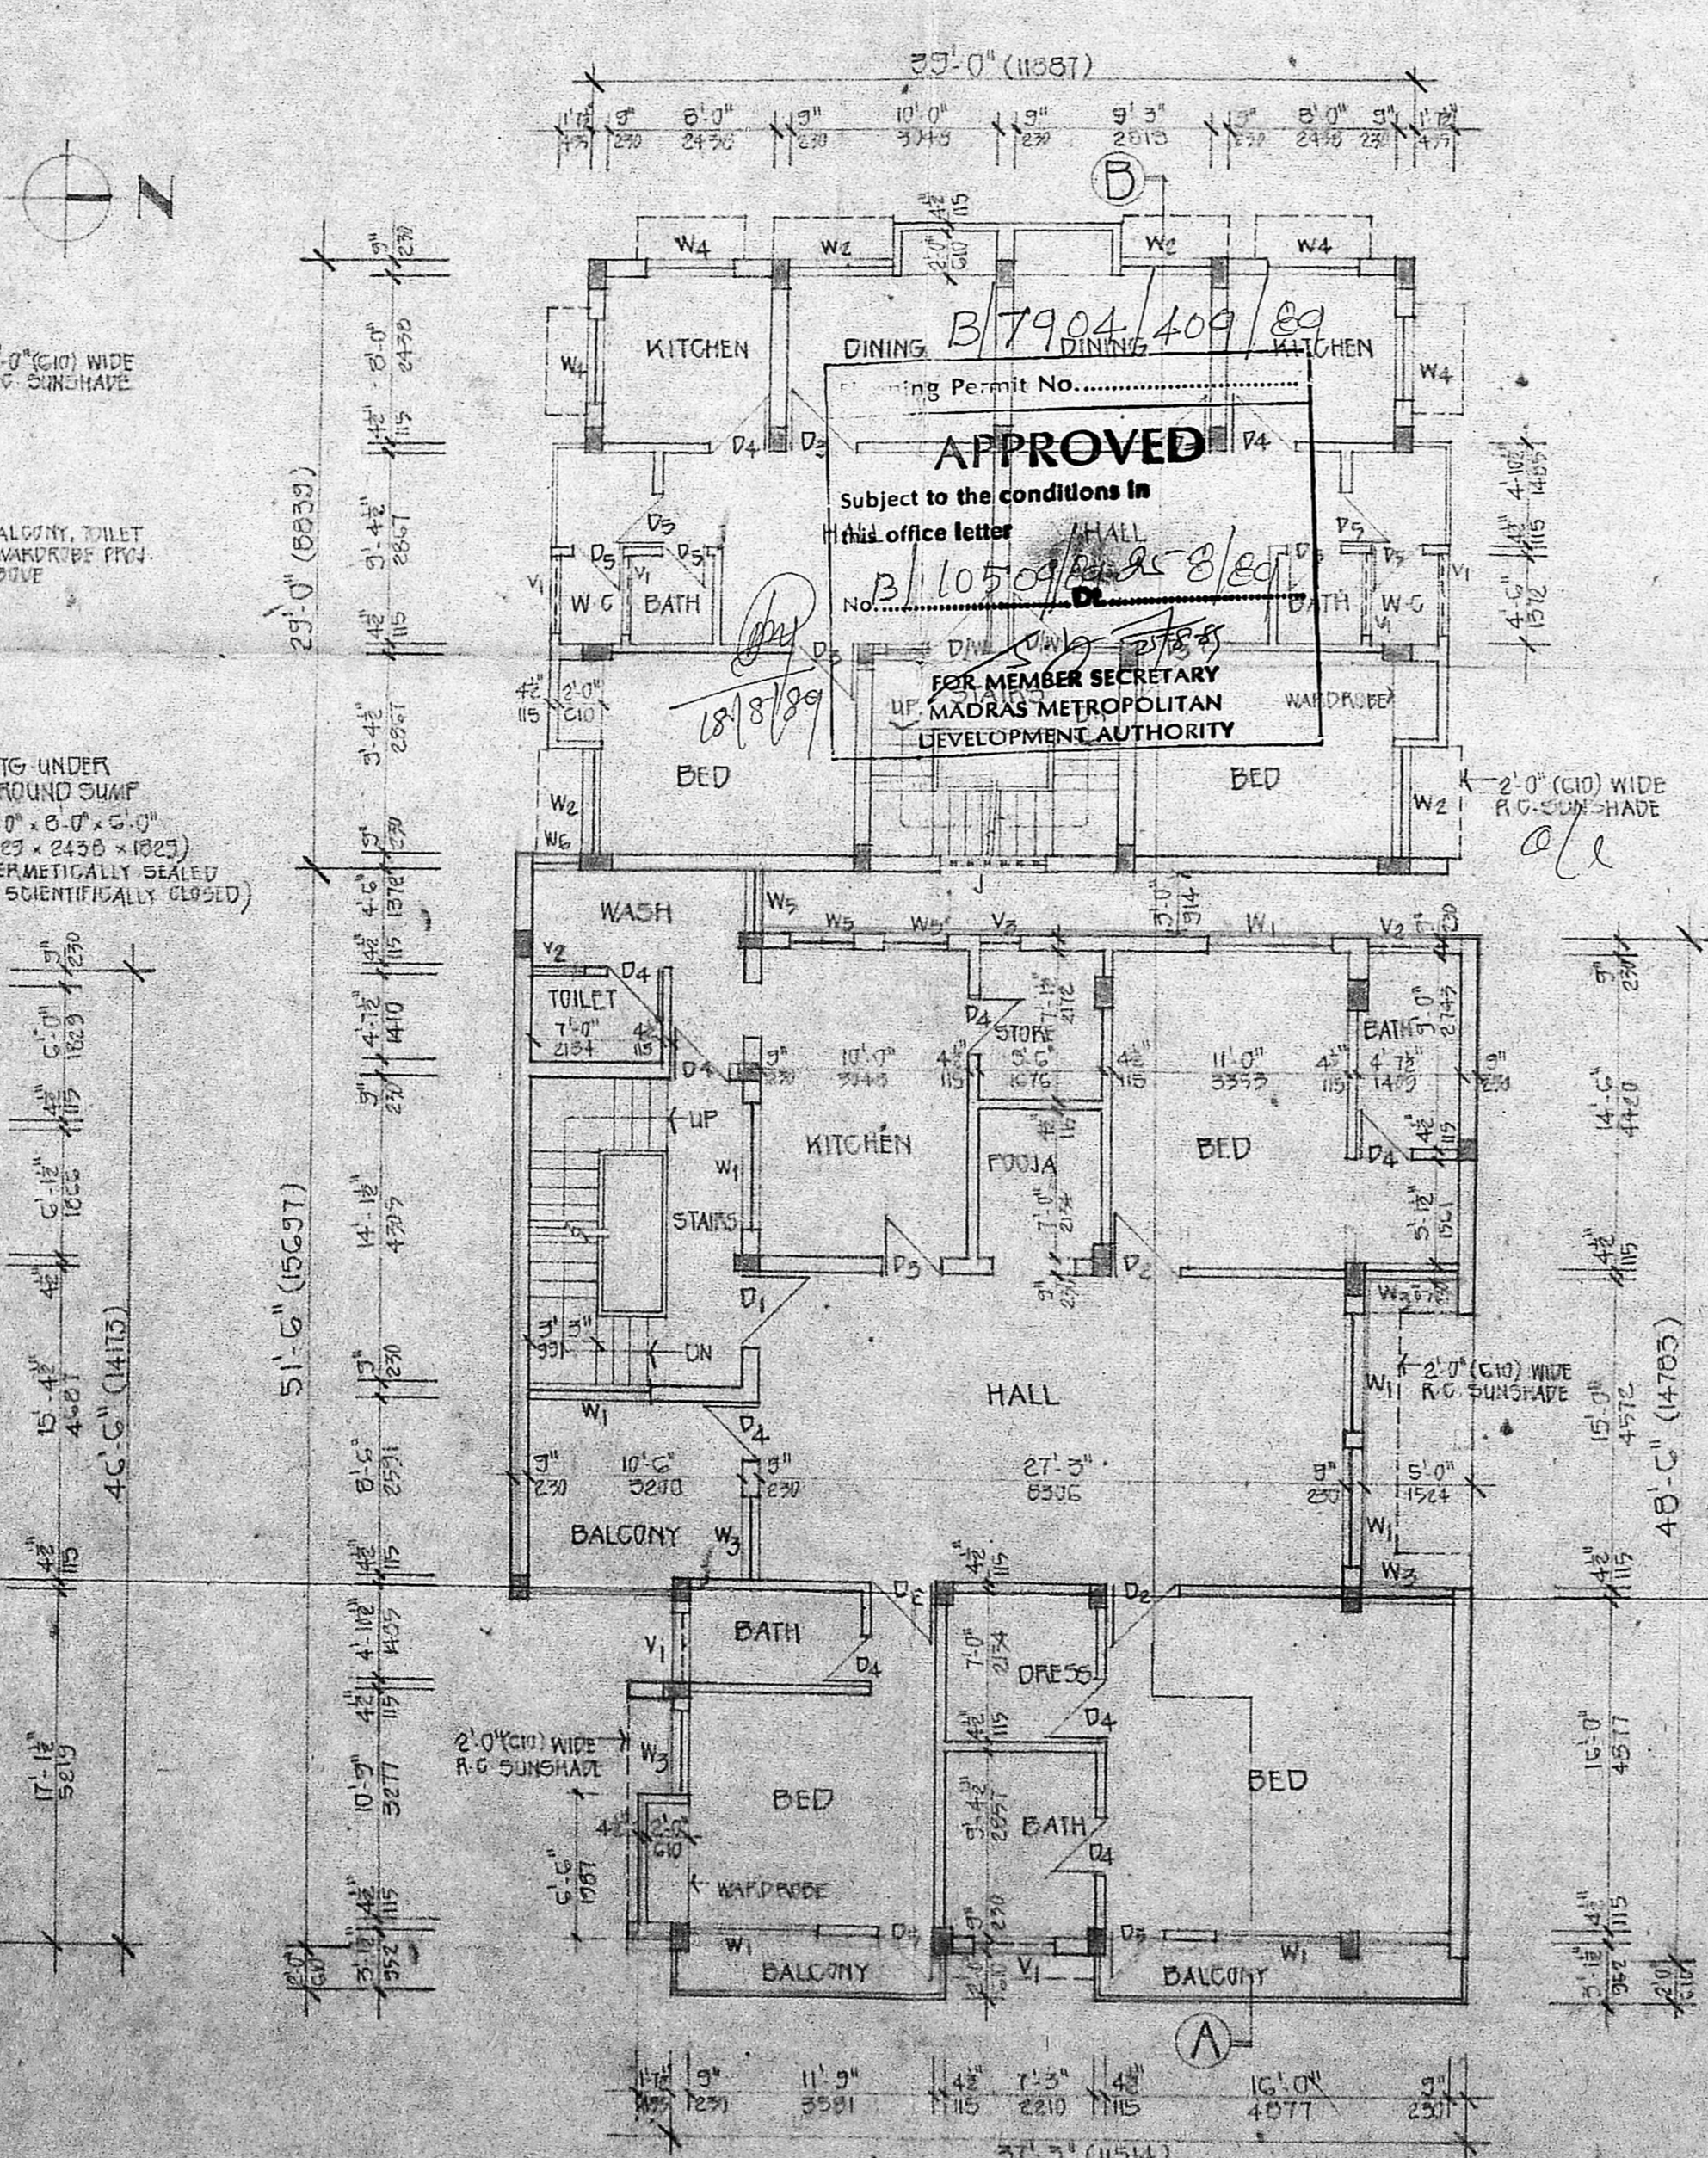

FIRST FLOOR PLAN.

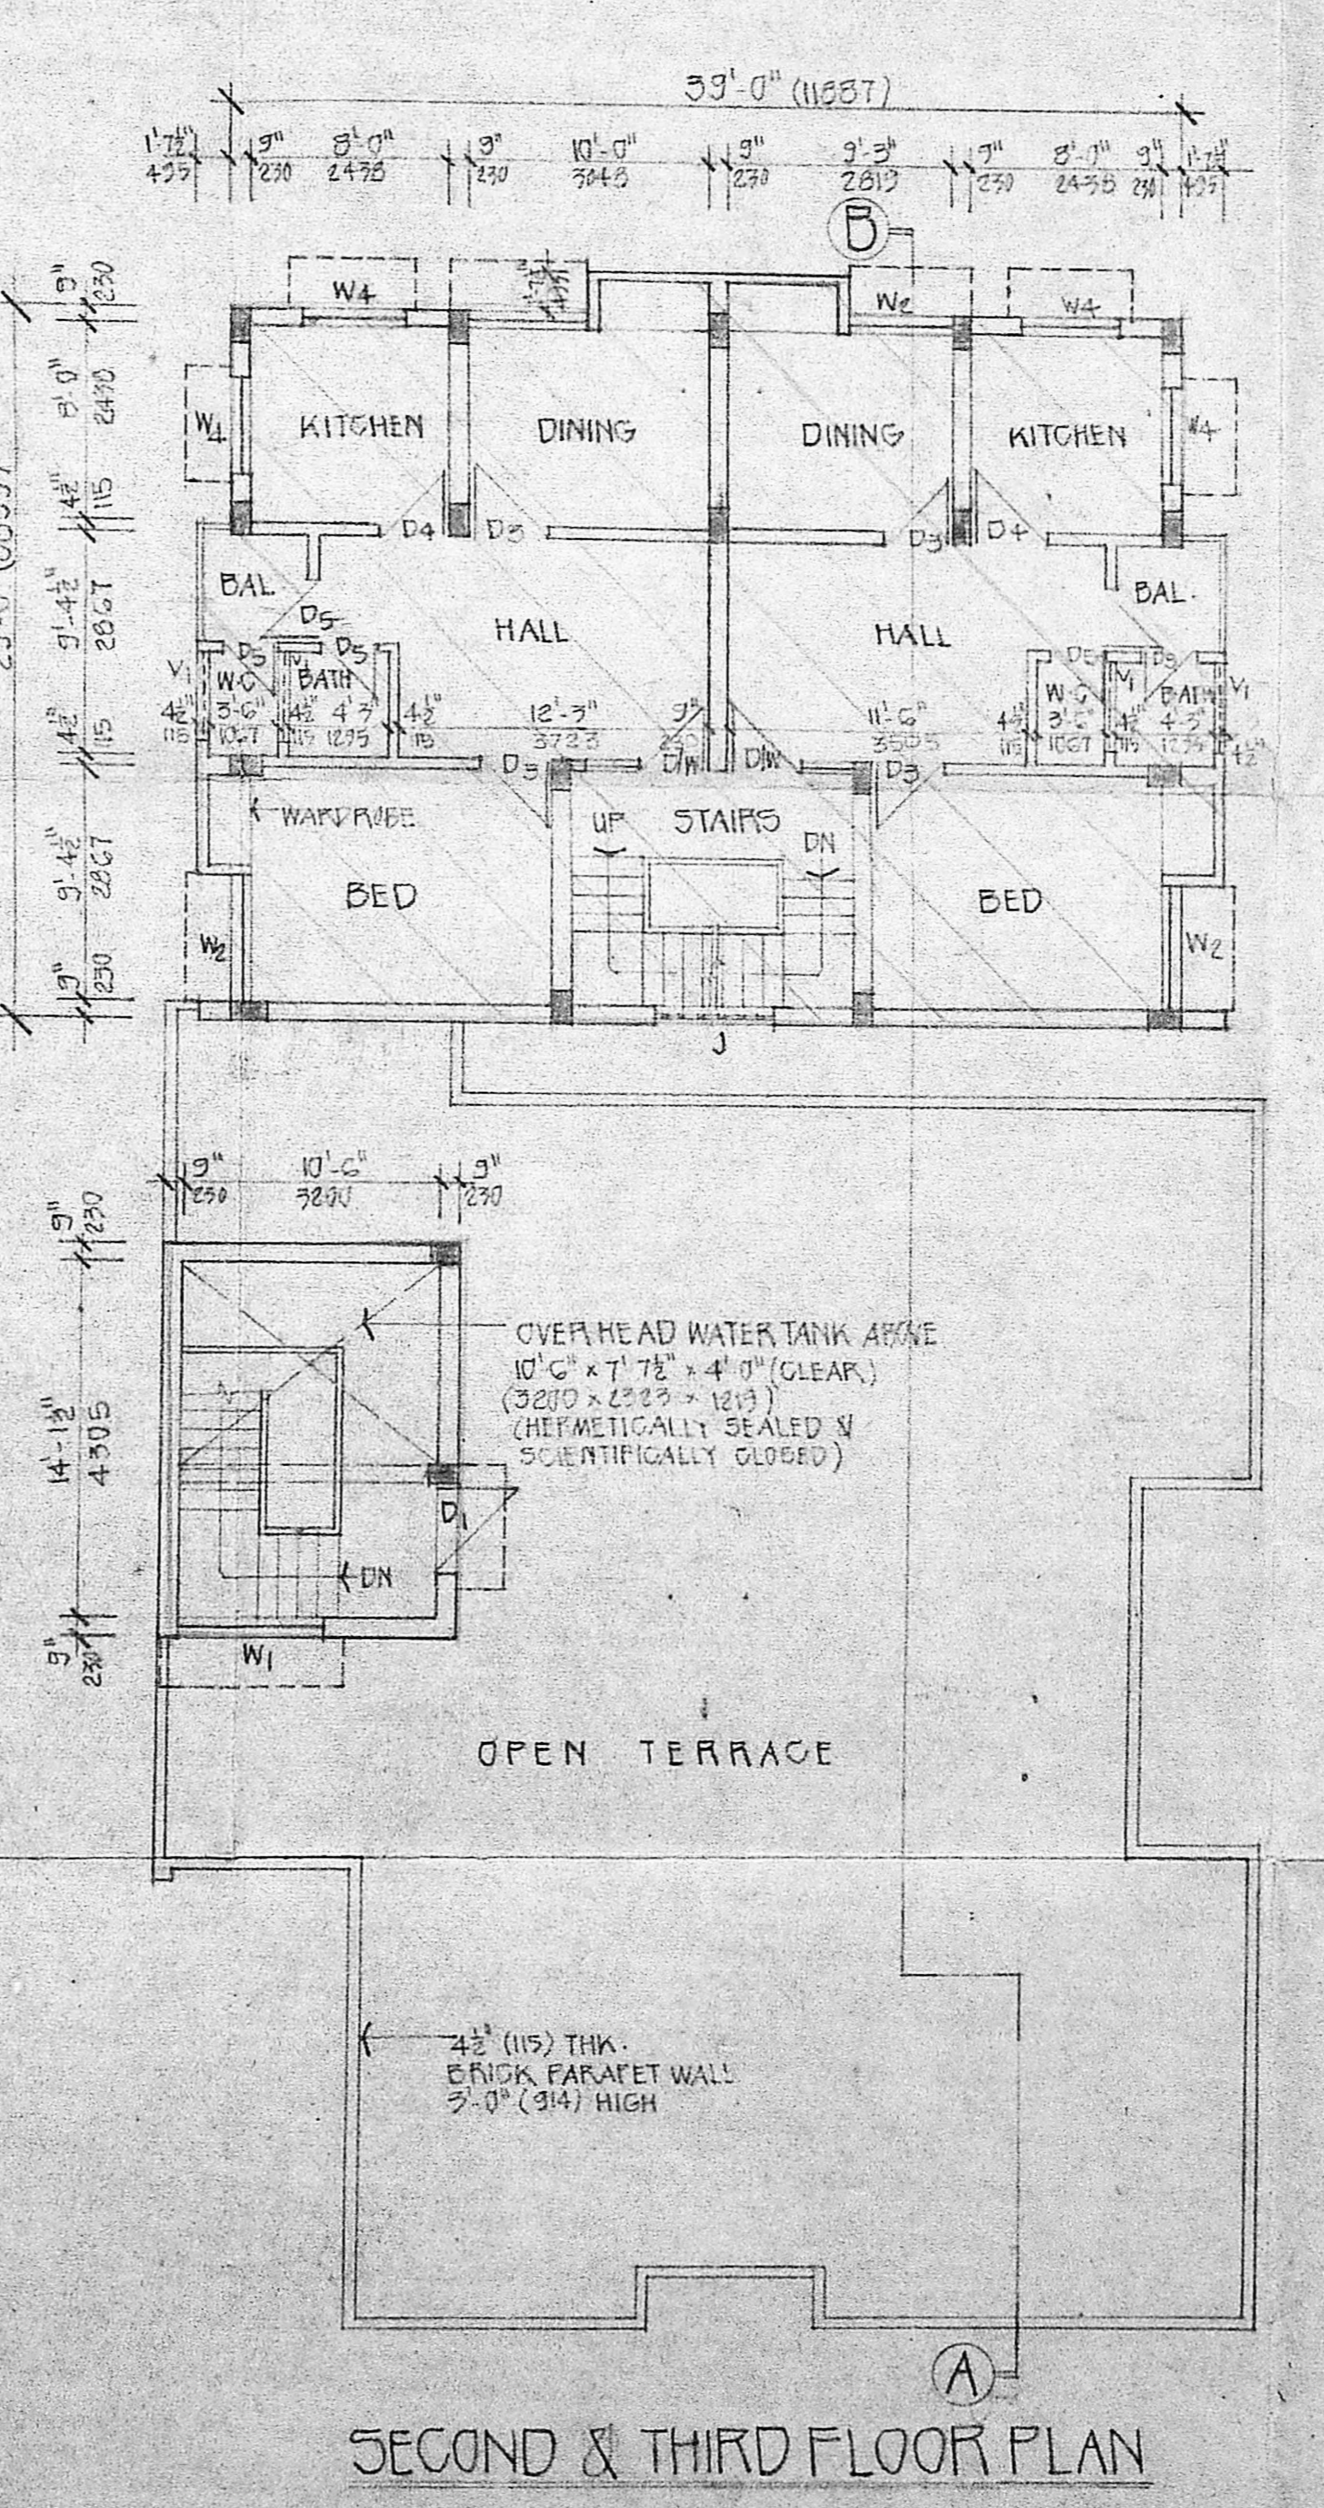

SECOND & THIRD FLOOR PLAN.

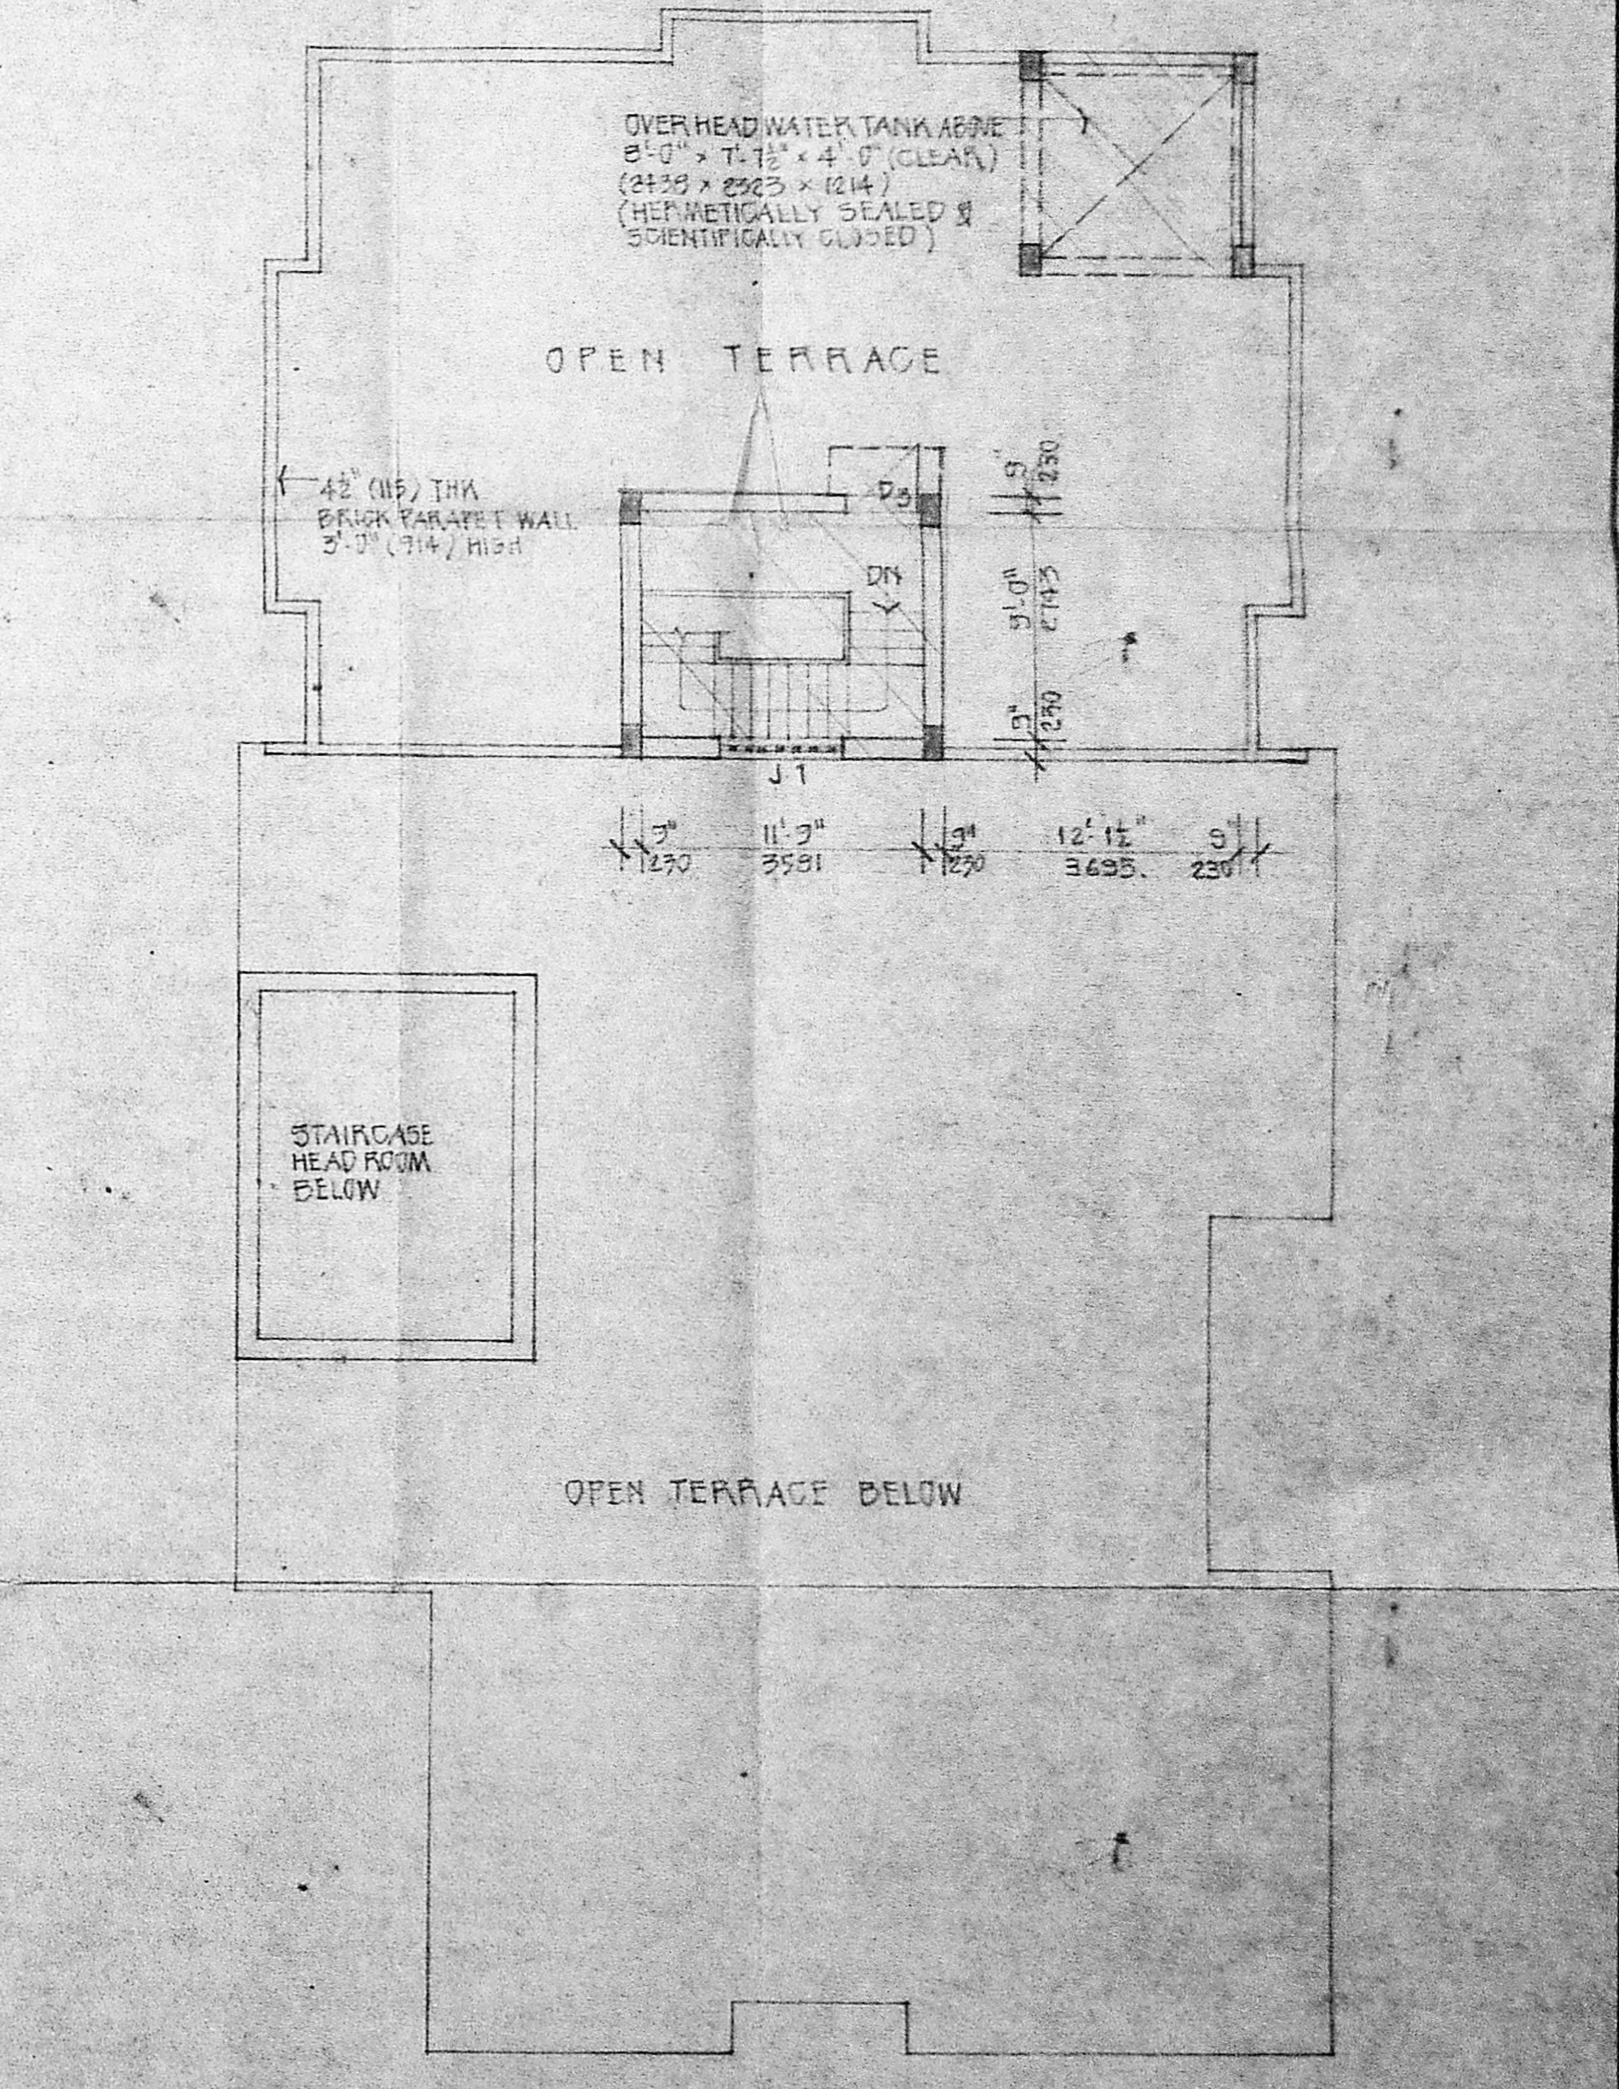

TERRACE FLOOR PLAN.

OWNER: P. Govindaraj, G. Rajanbala

SCALE	1" = 8'-0" (1:60)
DATE	10.12.1985
DRAWN	[Signature]
CHECKED	[Signature]

LICENSED SURVEYOR: SATNAM SINGH B.Arch., AID Architect & Interior Designer, 145 Purasawalkam High Road, Kolliy, Madras - 600 010.

LICENSED SURVEYOR CLASS-I No. RA-31

PROPOSED ADDITIONS TO BUILDING AT NO. 50, MOOKATHAL STREET, MADRAS-7. (ADDITIONS TO SANCTIONED B.A. NO. 14/86 & 15/86) DN. NO. 69, R.S. NO. 1273/5, BLOCK NO. 23.

ARCHITECT: SATNAM SINGH B.Arch., AID ARCHITECT & INTERIOR DESIGNER, 145 PURASAWALKAM HIGH ROAD, KOLLIDY, MADRAS - 600 010.

JOB NO. 164

DRG. NO. 8